



■ CIVIL ENGINEERING

Project No 3335607

# PARK TERRACE RETIREMENT VILLAGE

## FOR ASSESSMENT

Prepared for



By  
Beca

27 MARCH 2020





LEGEND: GENERAL

	SITE BOUNDARY
	EXTENT OF BASEMENT
	RETAINING WALL TO STRUCTURAL ENGINEER'S DETAILS
	MAJOR DESIGN CONTOUR (1m)
	MINOR DESIGN CONTOUR (0.1m)
	PROPOSED KERB AND NIB TO CSS SD 602
	PROPOSED KERB AND FLAT CHANNEL TO CSS SD 601
	PROPOSED KERB ONLY (FLUSH) TO CSS SD 602
	PROPOSED INTERPATH CHANNEL TO CSS SD 601
	PROPOSED VEHICLE CROSSING / CUT DOWN TO CCC CSS SD 602
	PROPOSED BUILDING FOOTPRINT (DEFINED AS THE MOST OUTER OUTLINE OF ANY VERTICAL STRUCTURE THAT INTERFACES TO THE GROUND)
<b>B12</b>	BUILDING NUMBER
FFL = 16.70m	FINISHED FLOOR LEVEL
	PROPOSED ATTENUATION TANK

LEGEND: EXISTING SERVICES

	EXISTING STORMWATER
	EXISTING SANITARY SEWER
	EXISTING WATERMAIN
	EXISTING GAS
	EXISTING FIBRE OPTIC CABLE
	EXISTING OVERHEAD POWER CABLE
	EXISTING STORMWATER MANHOLE
	EXISTING SUMP
	EXISTING CESSPIT
	EXISTING SANITARY SEWER MANHOLE
	EXISTING WATER METER
	EXISTING WATER HYDRANT
	EXISTING POWER BOX
	EXISTING POWER POLE
	EXISTING POWER TRANSFORMER
	EXISTING STREET LIGHT
	EXISTING TELECOMMUNICATIONS PLINTH
	EXISTING TRAFFIC LIGHT
	EXISTING UNKNOWN MANHOLE

LEGEND: PROPOSED SERVICES

	PROPOSED STORMWATER PIPE
	PROPOSED SLOT DRAIN AND "INLINE SUMP"
	PROPOSED SANITARY SEWER PIPE
	PROPOSED WATER (POTABLE)
	PROPOSED WATER (FIRE)
	PROPOSED STORMWATER MANHOLE TO CSS SD303
	PROPOSED STORMWATER SUMP TO CSS SD 325 WITH SUBMERGED OUTLET TO CSS SD 329
	PROPOSED SEWER MANHOLE TO CSS SD 303
	PROPOSED SLUICE VALVE
	PROPOSED FIRE HYDRANT TO CSS SD 412
	PROPOSED WATER METER
	PROPOSED REDUCED PRESSURE ZONE VALVE.
	PROPOSED SLAB DRAINAGE DOWNPIPE
	PROPOSED ROOF DRAINAGE DOWNPIPE
	PROPOSED STORMWATER RODDING EYE TO NZBC CLAUSE E1
	PROPOSED WASTEWATER RODDING EYE TO NZBC CLAUSE E1

DRAWING No.	Rev	DRAWING TITLE	DRAWING STATUS
038-RCT_401_C0-000	D	COVER SHEET	RESOURCE CONSENT
038-RCT_401_C0-000A	A	COVER SHEET	CONCEPT DESIGN
038-RCT_401_C0-001	D	LEGEND, DRAWING LIST AND GENERAL NOTES	RESOURCE CONSENT
038-RCT_401_C0-001A	A	LEGEND, DRAWING LIST AND GENERAL NOTES	CONCEPT DESIGN
038-RCT_401_C0-002	D	EXISTING SITE LAYOUT	CONCEPT DESIGN
038-RCT_401_C0-010	D	PROPOSED OVERALL SITE GRADING PLAN	RESOURCE CONSENT
038-RCT_401_C0-011	D	PROPOSED SITE GRADING PLAN SHEET 1 OF 3	CONCEPT DESIGN
038-RCT_401_C0-012	D	PROPOSED SITE GRADING PLAN SHEET 2 OF 3	CONCEPT DESIGN
038-RCT_401_C0-013	B	PROPOSED SITE GRADING PLAN SHEET 3 OF 3	CONCEPT DESIGN
038-RCT_401_C0-020	D	PROPOSED OVERALL SITE SERVICES PLAN	RESOURCE CONSENT
038-RCT_401_C0-021	D	PROPOSED SITE SERVICES PLAN SHEET 1 OF 3	CONCEPT DESIGN
038-RCT_401_C0-022	D	PROPOSED SITE SERVICES PLAN SHEET 2 OF 3	CONCEPT DESIGN
038-RCT_401_C0-023	B	PROPOSED SITE SERVICES PLAN SHEET 3 OF 3	CONCEPT DESIGN
038-RCT_401_C0-050	B	BISHOPSPARK EROSION AND SEDIMENT CONTROL PLAN	CONCEPT DESIGN
038-RCT_401_C0-051	B	PETERBOROUGH EROSION AND SEDIMENT CONTROL PLAN	CONCEPT DESIGN
038-RCT_401_C4-060	B	PROPOSED STORMWATER CONTAINER DEWATERING DEVICE	CONCEPT DESIGN
038-RCT_401_C4-061	B	PROPOSED DN1050 STORMWATER 360 TREATMENT DEVICE	CONCEPT DESIGN
038-RCT_401_C4-062	B	PROPOSED DN1200 STORMWATER 360 TREATMENT DEVICE	CONCEPT DESIGN

DRAWING INDEX

A	CONCEPT DESIGN		JK	IB	RJ
No.	Revision	By	Chk	Appd	Date
					27.03.20

Drawing Originator:		Original Scale (A1) NTS		Design		S.Crundwell		10.03.20		Approved For Construction*	
		Reduced Scale (A3) NTS		Drawn		P.Goundar		10.03.20		Date	
				Dwg Verifier		J.Stanton		20.03.20			
				Dwg Check		K.Aulakh		20.03.20			
* Refer to Revision 1 for Original Signature											

Client:	
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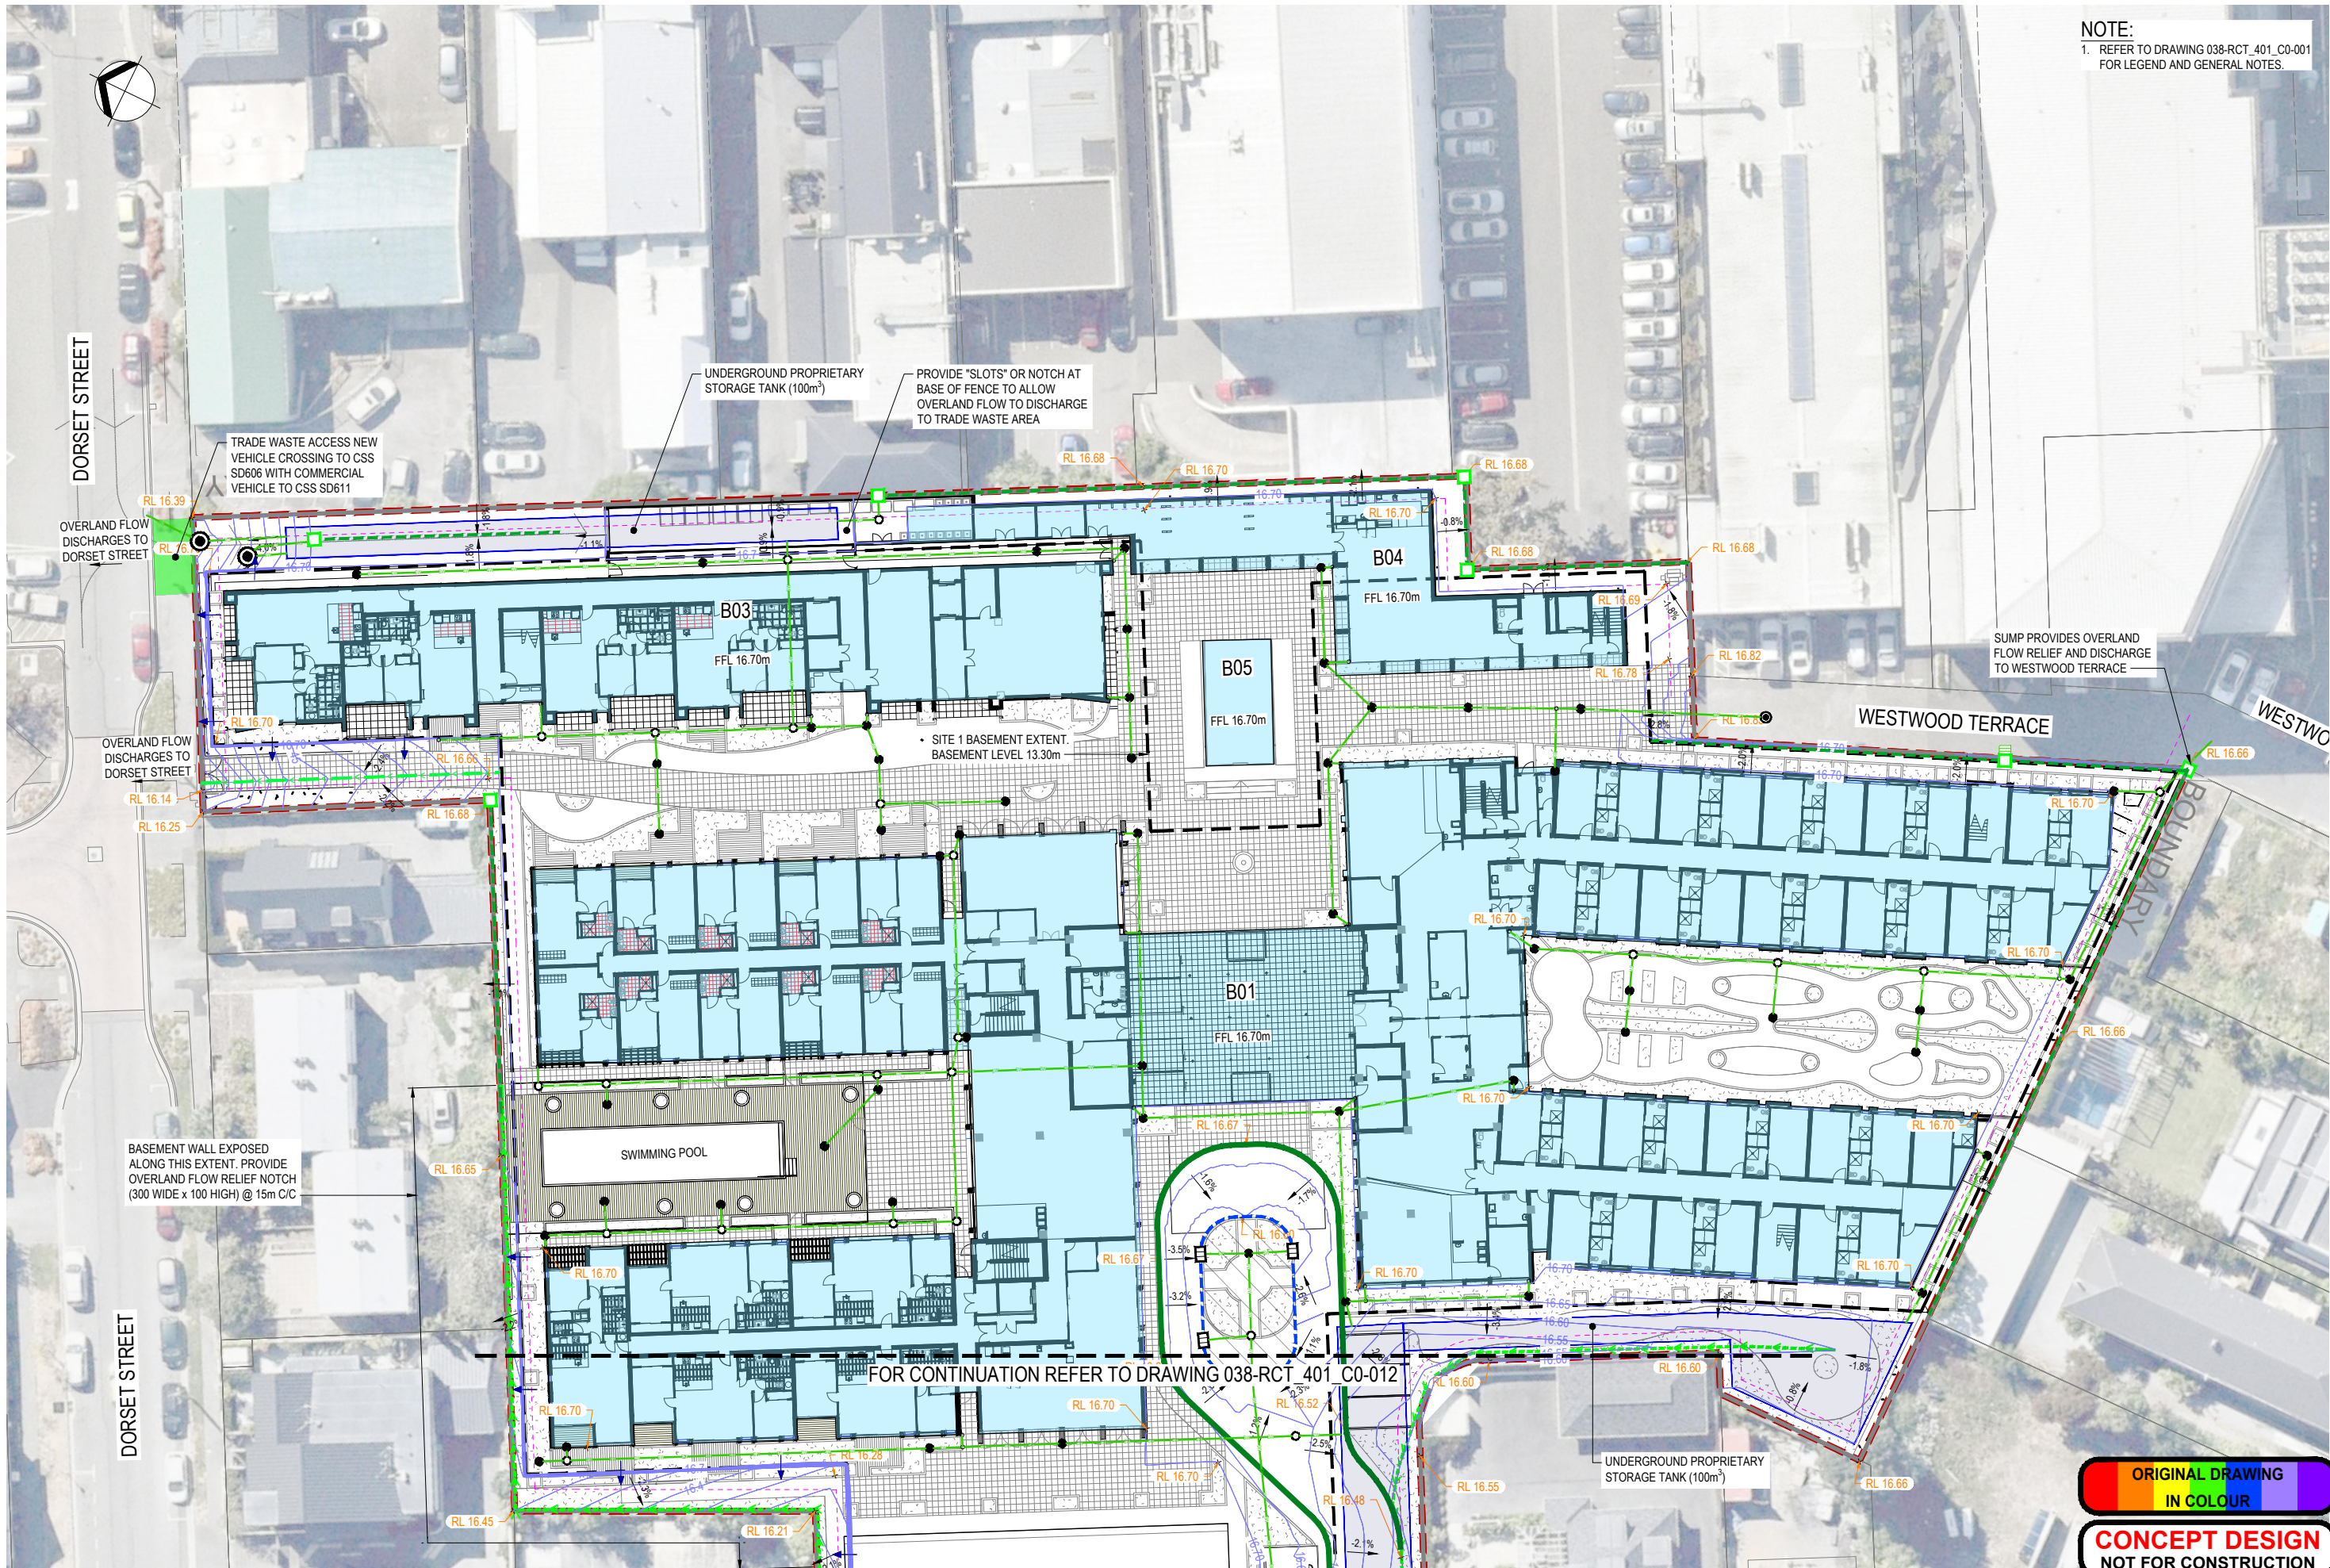
Project:	PARK TERRACE RETIREMENT VILLAGE
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Title:	LEGEND, DRAWING LIST AND GENERAL NOTES
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Discipline	CIVIL ENGINEERING
Drawing No.	038-RCT_401_C0-001A
Rev.	A



NOTE:  
1. REFER TO DRAWING 038-RCT\_401\_C0-001  
FOR LEGEND AND GENERAL NOTES.



D	CONCEPT DESIGN	JK	IB	BC	27.03.20
C	FOR APPROVAL	JK	IB	BC	20.03.20
B	FOR APPROVAL	HC	SC	BC	28.02.20
A	FOR APPROVAL	PJ	IB	RJ	14.11.19
No.	Revision	By	Chk	Appd	Date

Drawing Originator:  
**Beca**

Original Scale (A1)	Design	S.Crundwell	03.20	Approved For Construction*
1:250	Drawn	P.Goundar	03.20	
Reduced Scale (A3)	Design Check	J.Stanton	20.03.20	Date
1:500	Design Check	K.Aulakh	20.03.20	
	*Refer to Revision 1 for Original Signature			

Client:  
**RYMAN HEALTHCARE**


Project:  
**PARK TERRACE RETIREMENT VILLAGE**

Title:  
**PROPOSED SITE GRADING PLAN SHEET 1 OF 3**

Discipline	CIVIL ENGINEERING
Drawing No.	038-RCT_401_C0-011
Rev.	D

ORIGINAL DRAWING  
IN COLOUR  
**CONCEPT DESIGN**  
NOT FOR CONSTRUCTION




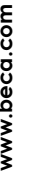

Discipline	
CIVIL ENGINEERING	
Drawing No.	Rev.
038-RCT_401_C0-012	D



NOTE:  
1. REFER TO DRAWING 038-RCT\_401\_C0-001 FOR LEGEND AND GENERAL NOTES.

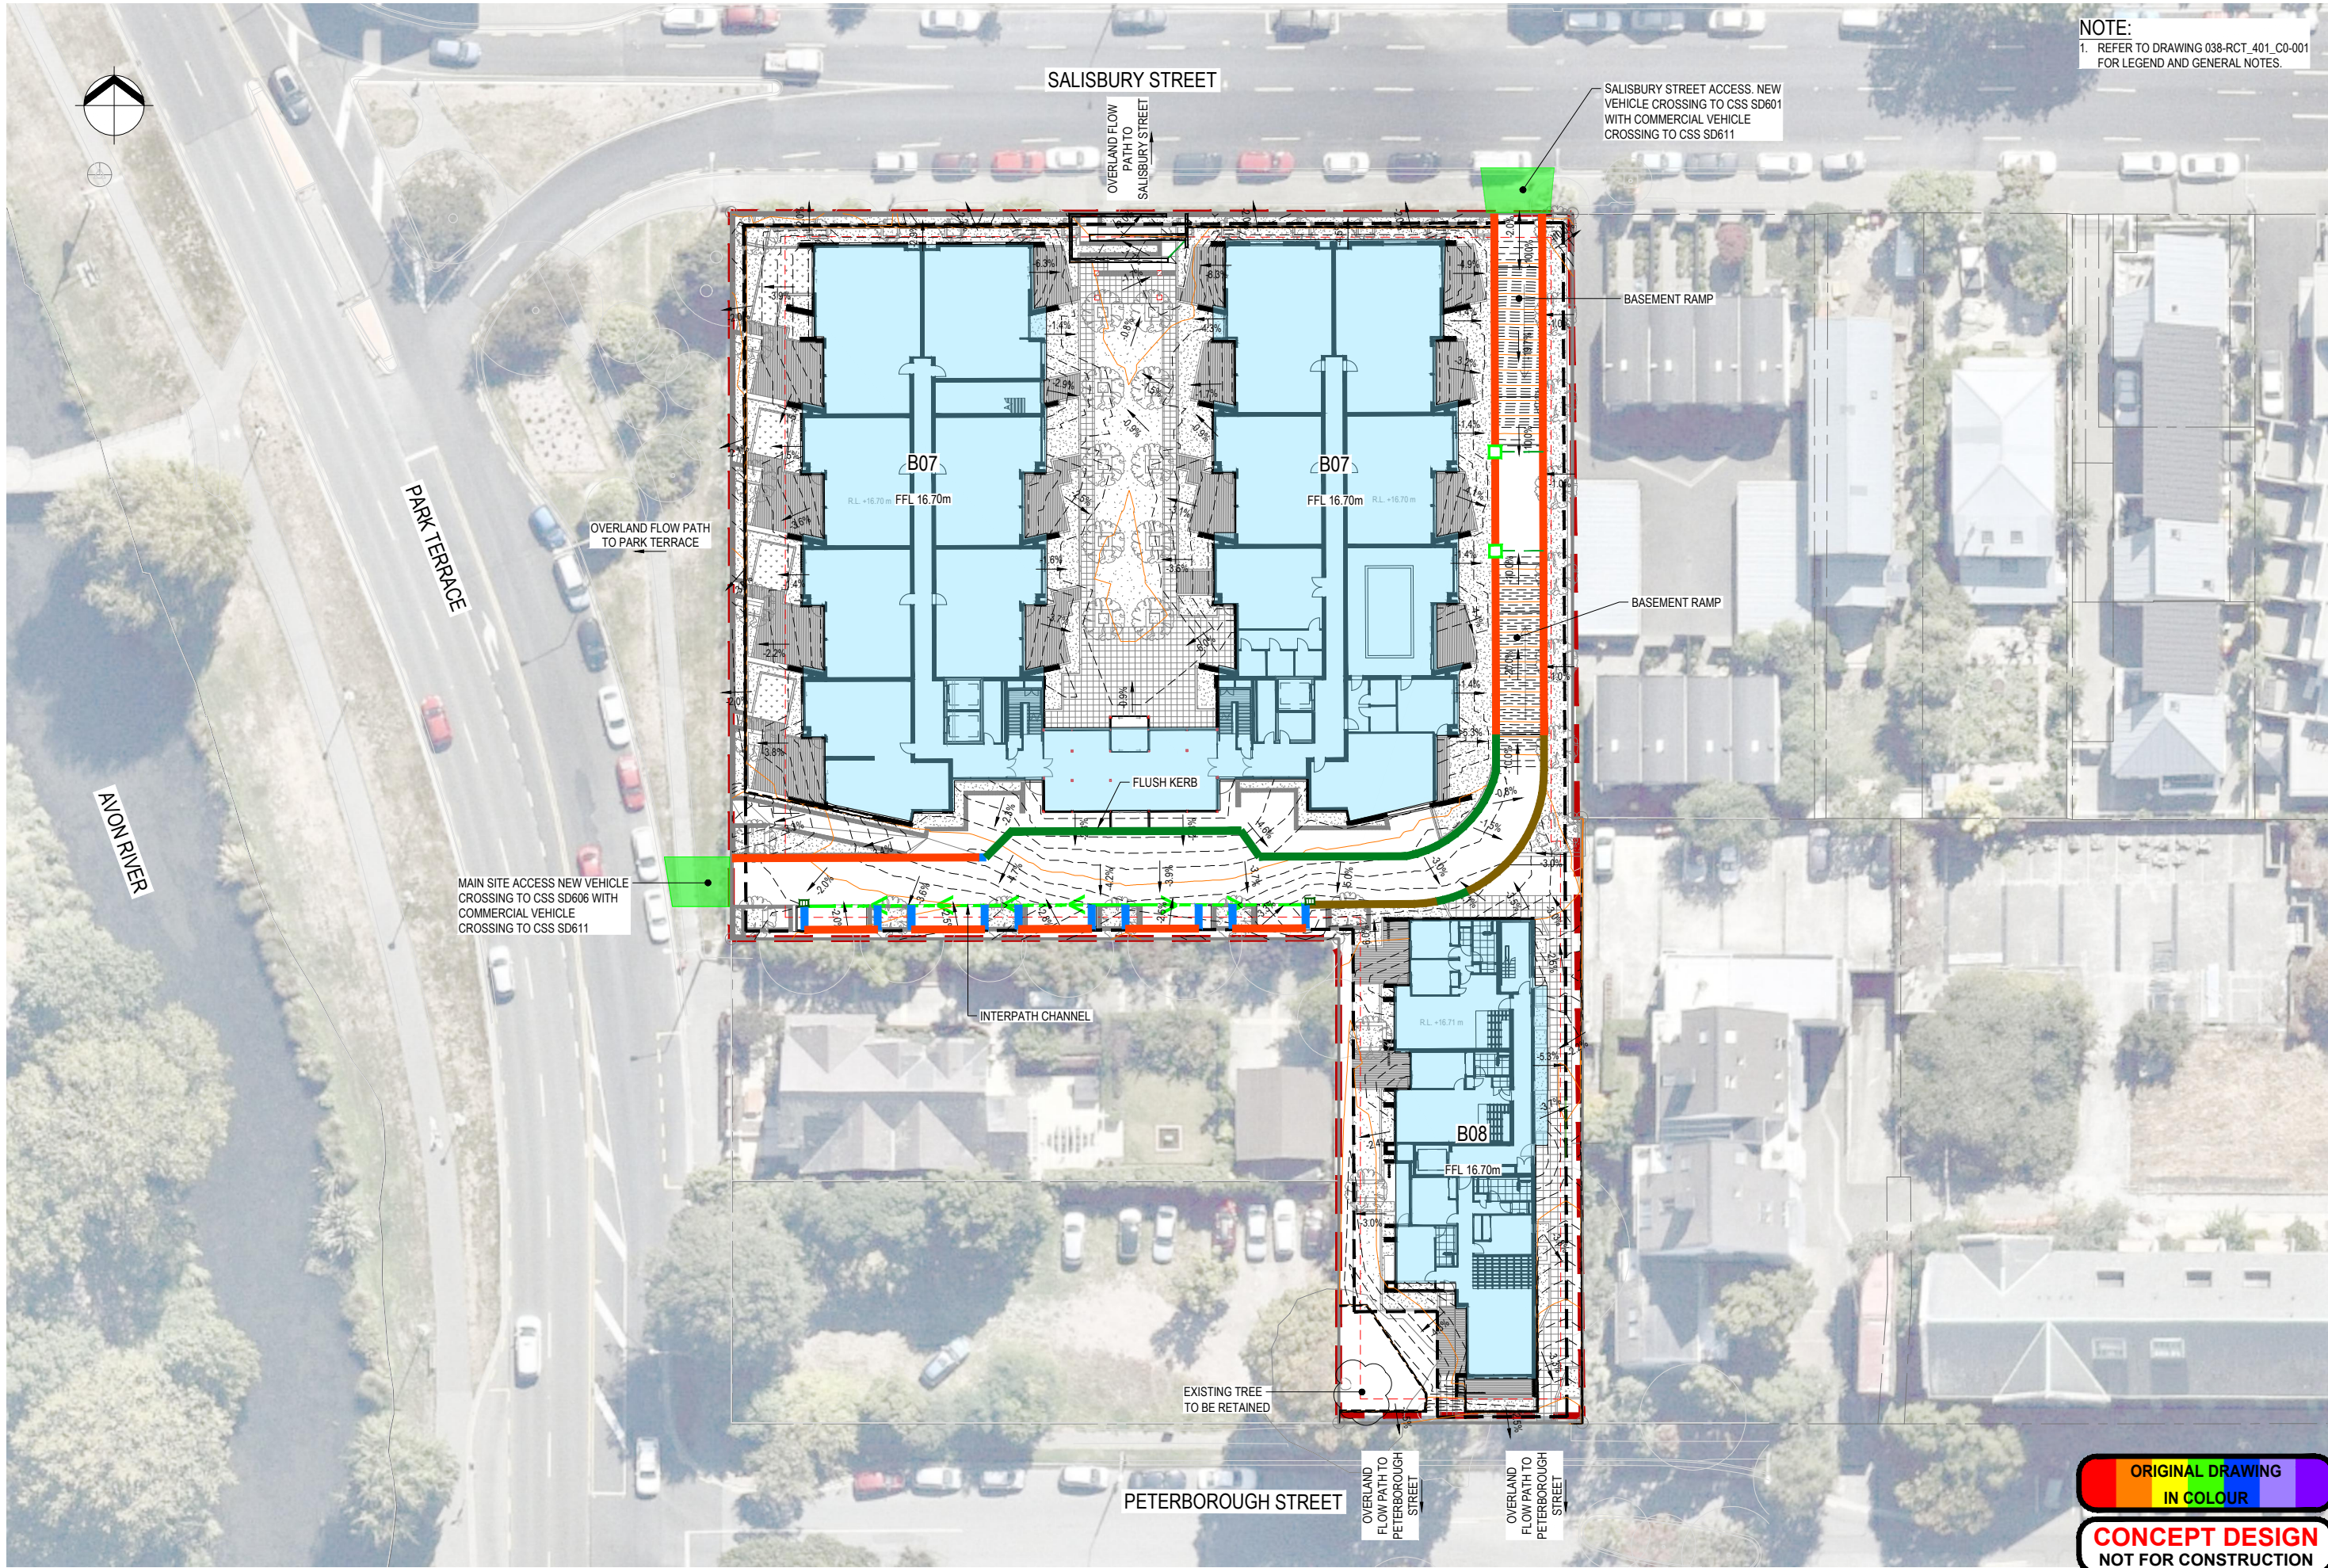

B	CONCEPT DESIGN	JK	IB	BC	27.03.20
A	FOR APPROVAL	JK	IB	RJ	20.03.20
No.	Revision	By	Chk	Appd	Date

Drawing Originator:

**Beca**

Original Scale (A1)	Design	S.Crundwell	03.20	Approved For Construction*
1:250	Drawn	J.Knox	03.20	
Reduced Scale (A3)	Design Verifier	J.Stanton	20.03.20	Date
1:500	Design Check	K.Aulakh	20.03.20	
	* Refer to Revision 1 for Original Signature			

Client:

**RYMAN HEALTHCARE**

Project:

PARK TERRACE RETIREMENT VILLAGE

Title:

PROPOSED SITE GRADING PLAN  
SHEET 3 OF 3

ORIGINAL DRAWING  
IN COLOUR


CONCEPT DESIGN  
NOT FOR CONSTRUCTION

Discipline	CIVIL ENGINEERING
Drawing No.	038-RCT_401_C0-013
Rev.	B



NOTES:

1. REFER TO DRAWING 038-RCT\_401\_C0-001 FOR LEGEND AND GENERAL NOTES.

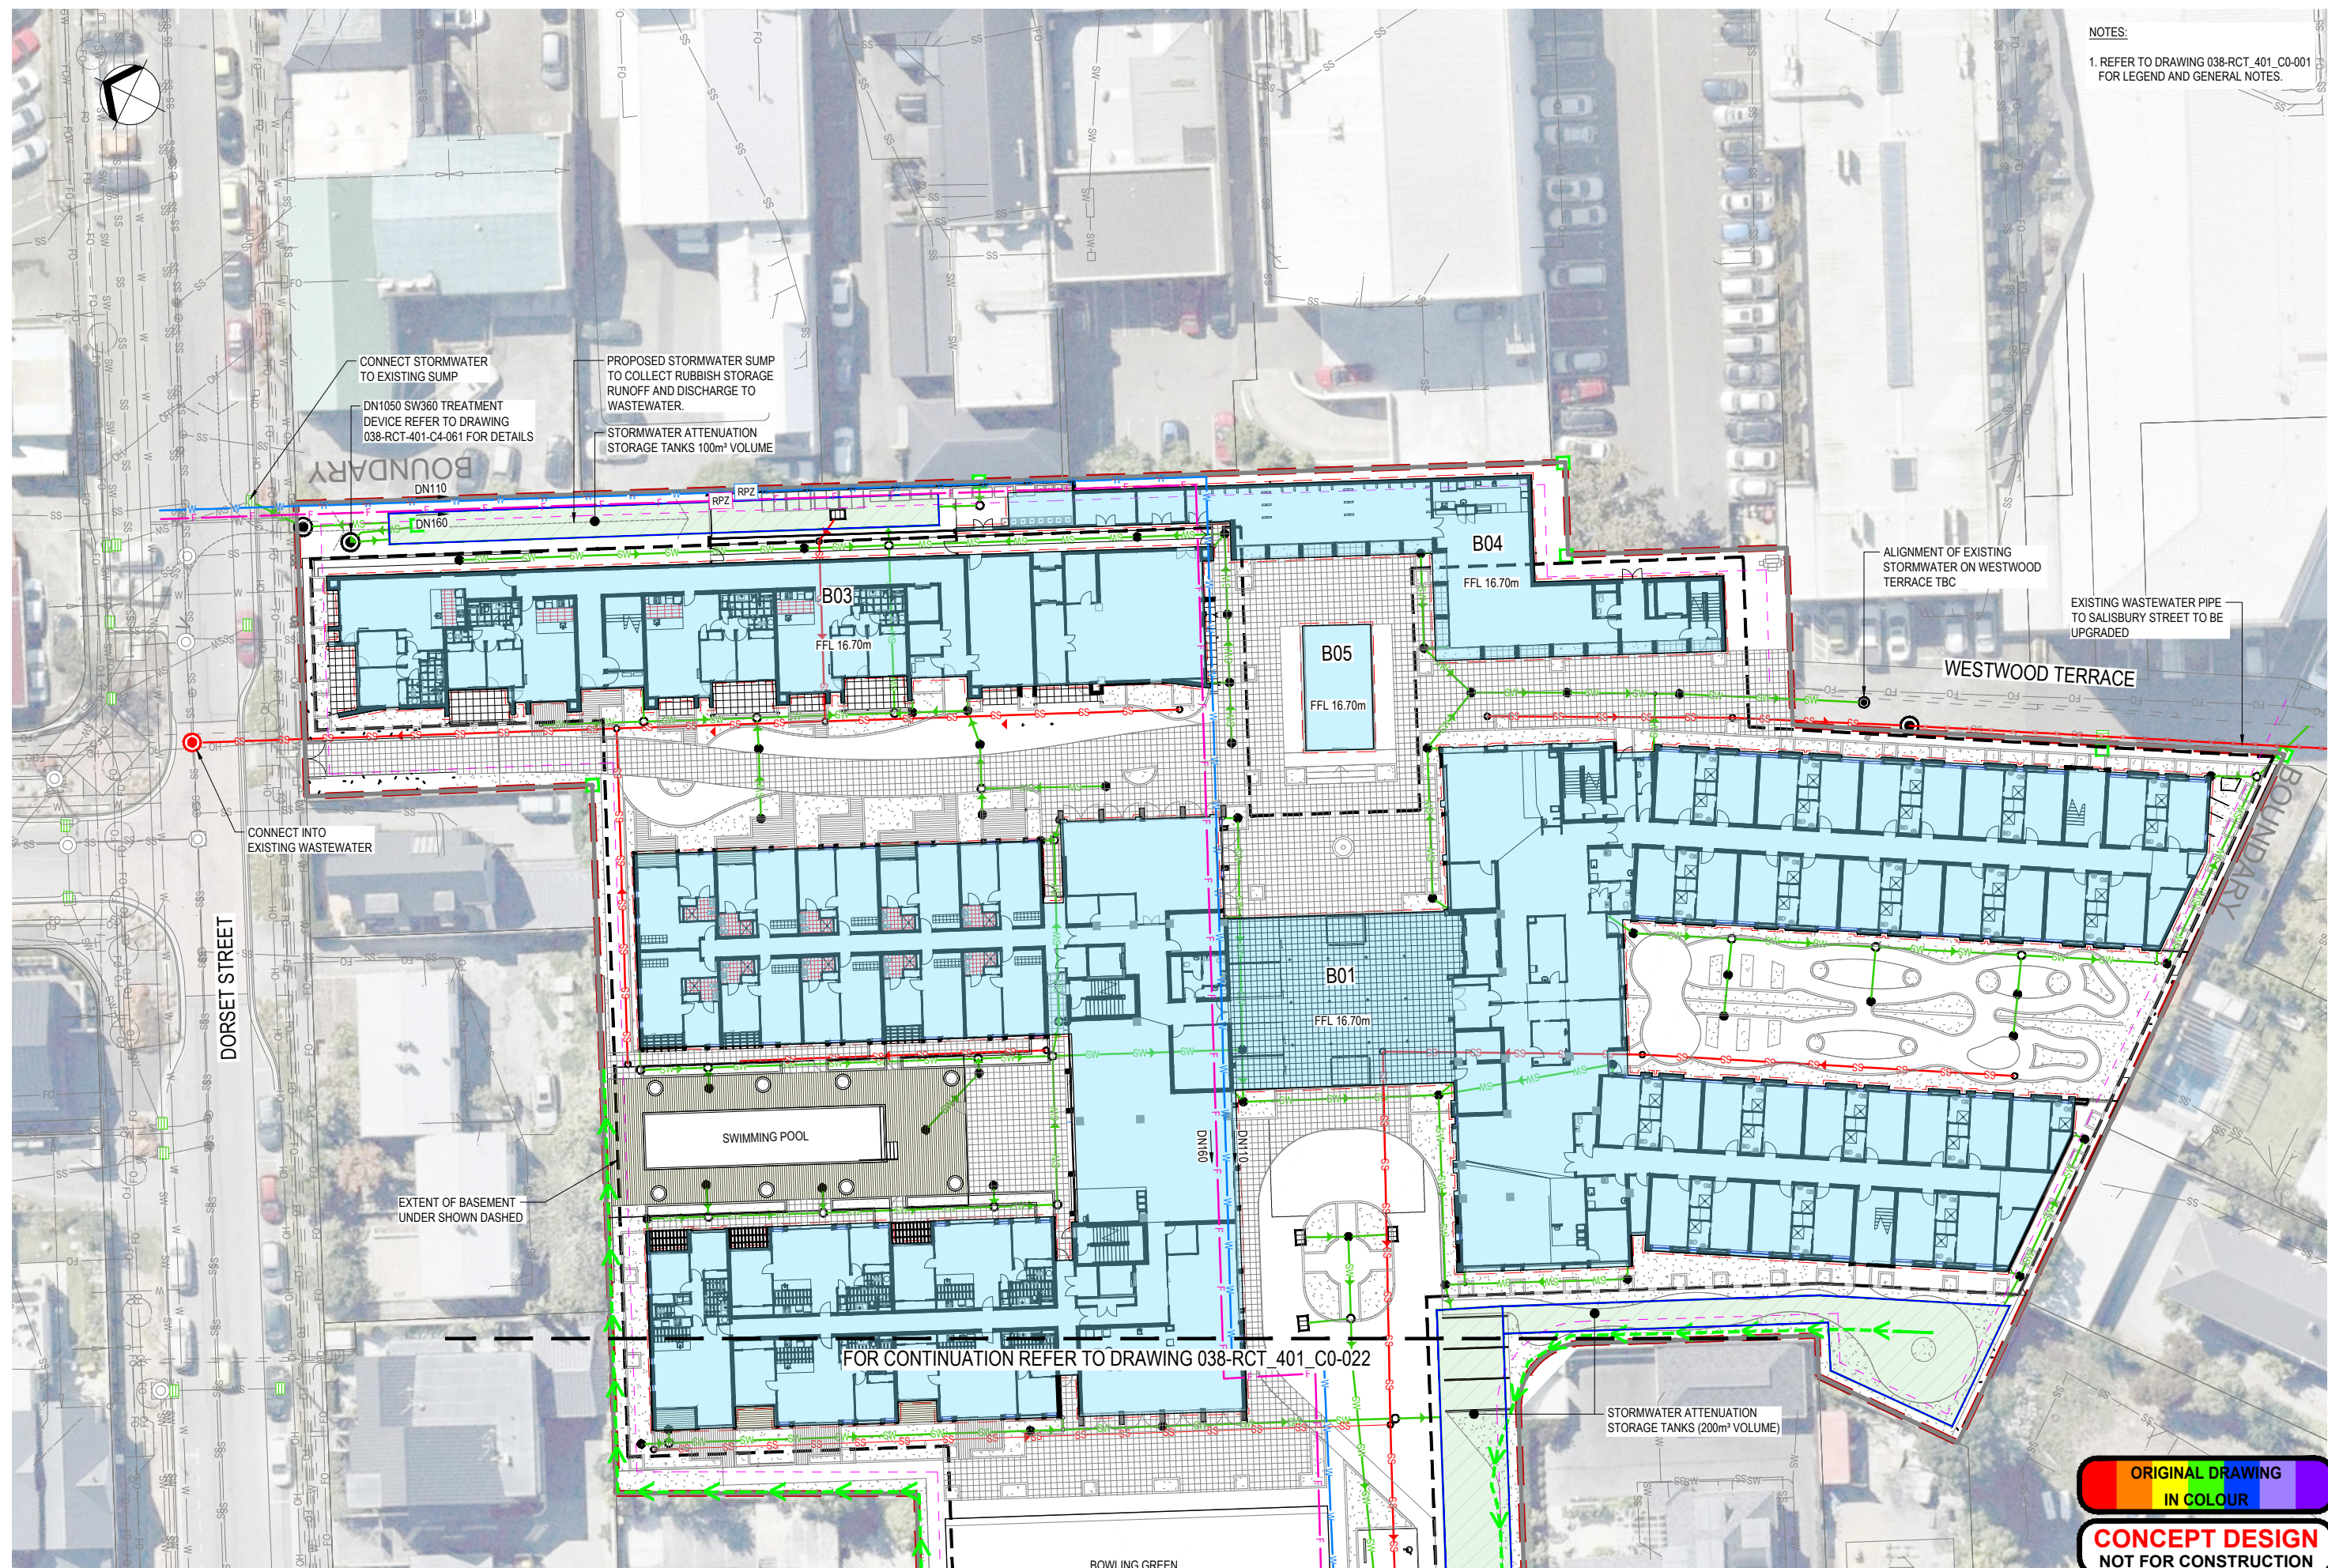

D	CONCEPT DESIGN	JK	IB	BC	27.03.20
C	FOR APPROVAL	JK	IB	BC	20.03.20
B	FOR APPROVAL	HC	SC	BC	28.02.20
A	FOR APPROVAL	PJ	IB	RJ	14.11.19
No.	Revision	By	Chk	Appd	Date

Drawing Originator:



Original Scale (A1)	Design	S.Crundwell	10.03.20	Approved For Construction*
1:250	Drawn	P.Goundar	10.03.20	
Reduced Scale (A3)	Design Checker	J.Stanton	20.03.20	
1:500	Design Checker	K.Aulakh	20.03.20	Date
	*Refer to Revision 1 for Original Signature			

Client:



Project:

PARK TERRACE  
RETIREMENT VILLAGE

Title:

PROPOSED  
SITE SERVICES PLAN  
SHEET 1 OF 3

Discipline:

CIVIL ENGINEERING

Drawing No.

038-RCT\_401\_C0-021

Rev.

D





NOTES:  
1. REFER TO DRAWING 038-RCT\_401\_C0-001 FOR LEGEND AND GENERAL NOTES.

ORIGINAL DRAWING  
IN COLOUR

CONCEPT DESIGN  
NOT FOR CONSTRUCTION

D	CONCEPT DESIGN	JK	IB	BC	27.03.20
C	FOR APPROVAL	JK	IB	BC	20.03.20
B	FOR APPROVAL	HC	SC	BC	28.02.20
A	FOR APPROVAL	PJ	IB	RJ	14.11.19
No.	Revision	By	Chk	Appd	Date

Drawing Originator:

Original Scale (A1)	Design	S.Crundwell	10.03.20	Approved For Construction*
1:250	Drawn	P.Goundar	10.03.20	
Reduced Scale (A3)	Design Verifier	J.Stanton	20.03.20	Date
1:500	Design Check	K.Aulakh	20.03.20	
	*Refer to Revision 1 for Original Signature			


Client:

Project: PARK TERRACE RETIREMENT VILLAGE

Title: PROPOSED SITE SERVICES PLAN SHEET 2 OF 3

Discipline	CIVIL ENGINEERING
Drawing No.	038-RCT_401_C0-022
Rev.	D



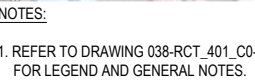

B	CONCEPT DESIGN	JK	IB	BC	27.03.20
A	FOR APPROVAL	JK	IB	BC	20.03.20
No.	Revision	By	Chk	Appd	Date



Original Scale (A1)	1:250
Reduced Scale (A3)	1:500

Design	S.Crundwell	10.03.20	Approved For Construction*
Drawn	J.Knox	20.03.20	
Dsg Verifier	J.Stanton	20.03.20	
Dwg Check	K.Aulakh	20.03.20	Date

\* Refer to Revision 1 for Original Signature



**RYMAN**  
HEALTHCARE

PARK TERRACE  
RETIREMENT VILLAGE

PROPOSED  
SITE SERVICES PLAN  
SHEET 3 OF 3

Discipline		CIVIL ENGINEERING
Drawing No.	038-RCT_401_C0-023	Rev B





B		CONCEPT DESIGN	JK	IB	BC	27.03.20
A		FOR APPROVAL	JK	IB	BC	20.03.20
No.	Revision		By	Chk	Appd	Date

Drawing Originator:

Original Scale (A1)	Design	C.Blyth	28.02.20	Approved For Construction*
1:250	Drawn	J.Knox	20.03.20	
Reduced Scale (A3)	Design Checker	M.Rademaker	28.02.20	Date
1:500	Dwg Check	I.Bannon	20.03.20	
* Refer to Revision 1 for Original Signature				

Client:

Project: PARK TERRACE RETIREMENT VILLAGE

Title: BISHOPSPARK EROSION AND SEDIMENT CONTROL PLAN

Discipline	CIVIL ENGINEERING	
Drawing No.	038-RCT_401_C0-050	Rev. B





**LEGEND**

DISCHARGE POINT

SILT FENCE

STABILISED AREA

ORIGINAL DRAWING  
IN COLOUR

**CONCEPT DESIGN**  
NOT FOR CONSTRUCTION

B	CONCEPT DESIGN	JK	IB	BC	27.03.20
A	FOR APPROVAL	JK	IB	BC	20.03.20
No.	Revision	By	Chk	Appd	Date

Drawing Originator:

**Beca**

Original Scale (A1)	Design	C.Blyth	28.02.20	Approved For Construction*
1:250	Drawn	J.Knox	20.03.20	
Reduced Scale (A3)	Design Verifier	M.Rademaker	28.02.20	Date
1:500	Dwg Check	I.Bannon	20.03.20	
	* Refer to Revision 1 for Original Signature			

Client:

**RYMAN HEALTHCARE**

Project:

PARK TERRACE  
RETIREMENT VILLAGE

Title:


PETERBOROUGH  
EROSION AND SEDIMENT  
CONTROL PLAN

Discipline	CIVIL ENGINEERING
Drawing No.	038-RCT_401_C0-051
Rev.	B



NOTES

1. NOT TO SCALE
2. MULTIPLE BAFFLES CAN BE INSTALLED AS APPROPRIATE.
3. MULTIPLE CONTAINERS CAN BE CONNECTED IN UNISON FOR ADDITIONAL TREATMENT.
4. FLOCCULATION TO BE CONSIDERED INDEPENDENTLY.
5. SCHEMATIC ONLY TO BE CONSIDERED ONCE DEVICE AND APPROPRIATE CONTAINERS ARE SOUGHT.

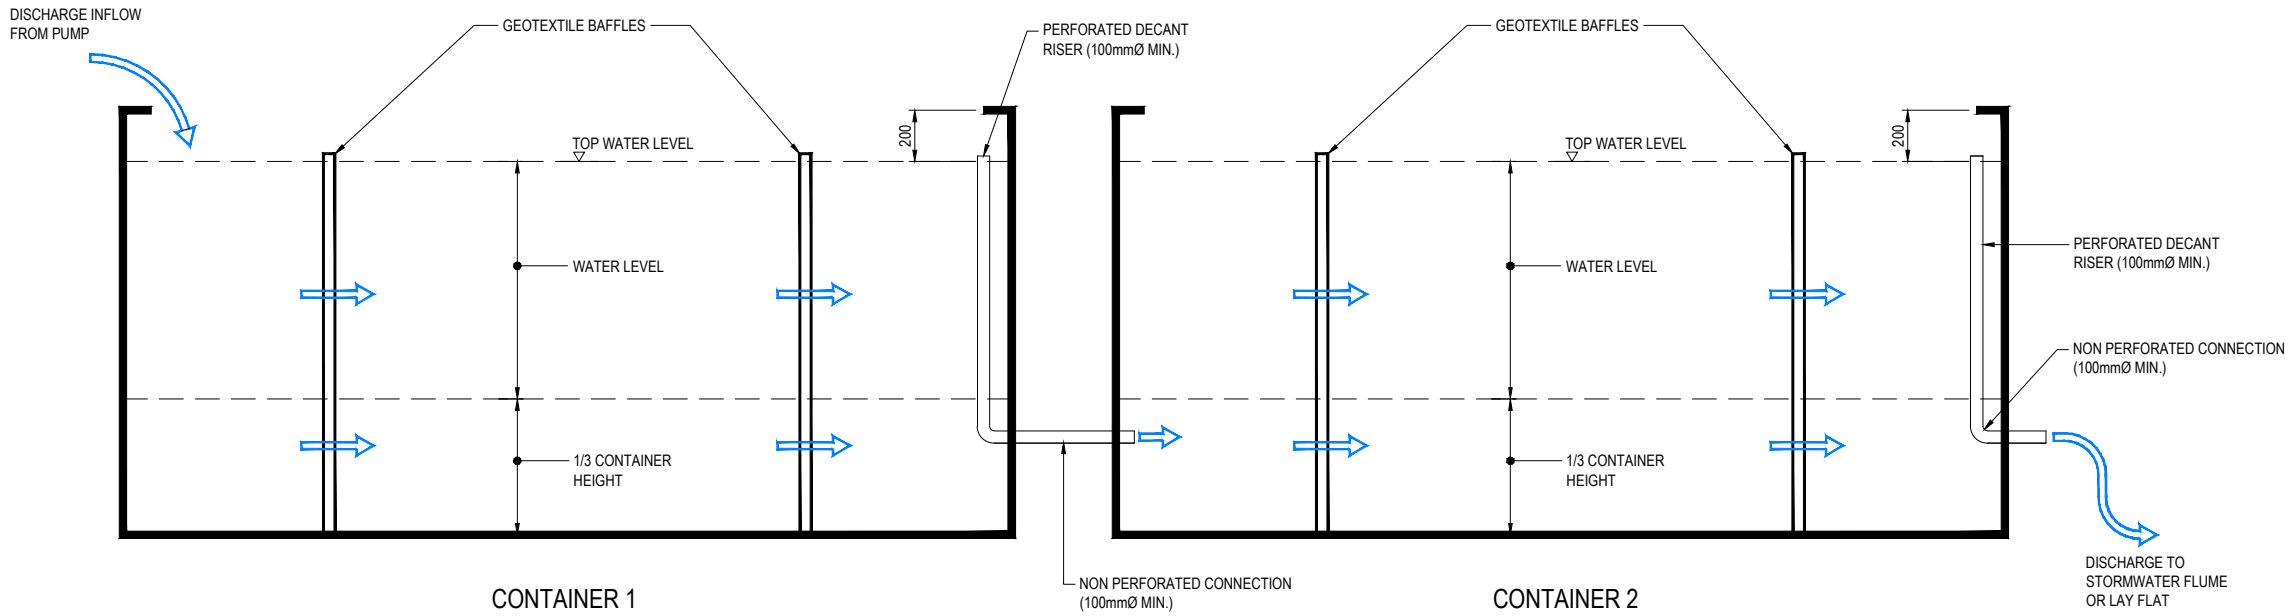

SCHEMATIC CROSS-SECTION - EXAMPLE CONTAINER DEWATERING DEVICE  
SCALE NTS

B	CONCEPT DESIGN	JK	IB	BC	27.03.20
A	FOR APPROVAL	JK	IB	BC	20.03.20
No.	Revision	By	Chk	Appd	Date



Original Scale (A1)	Design	C.Blyth	28.02.20	Approved For Construction*
NTS	Drawn	J.Knox	20.03.20	
Reduced Scale (A3)	Dwg Verifier	M.Rademaker	28.02.20	
NTS	Dwg Check	I.Bannon	20.03.20	Date
* Refer to Revision 1 for Original Signature				





Project: PARK TERRACE RETIREMENT VILLAGE

Title: PROPOSED STORMWATER CONTAINER DEWATERING DEVICE

CONCEPT DESIGN  
NOT FOR CONSTRUCTION

Discipline	CIVIL ENGINEERING
Drawing No.	038-RCT_401_C4-060
Rev.	B



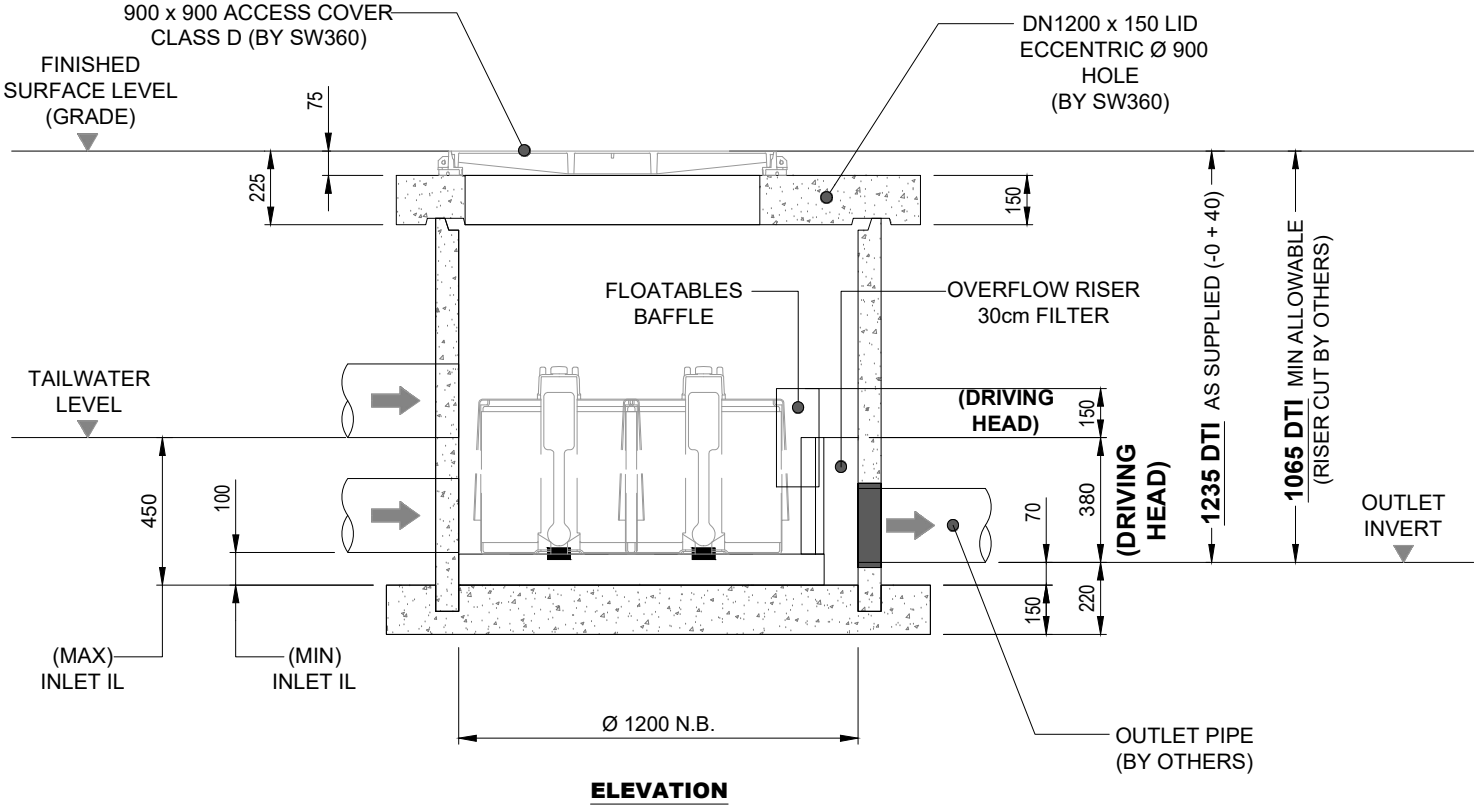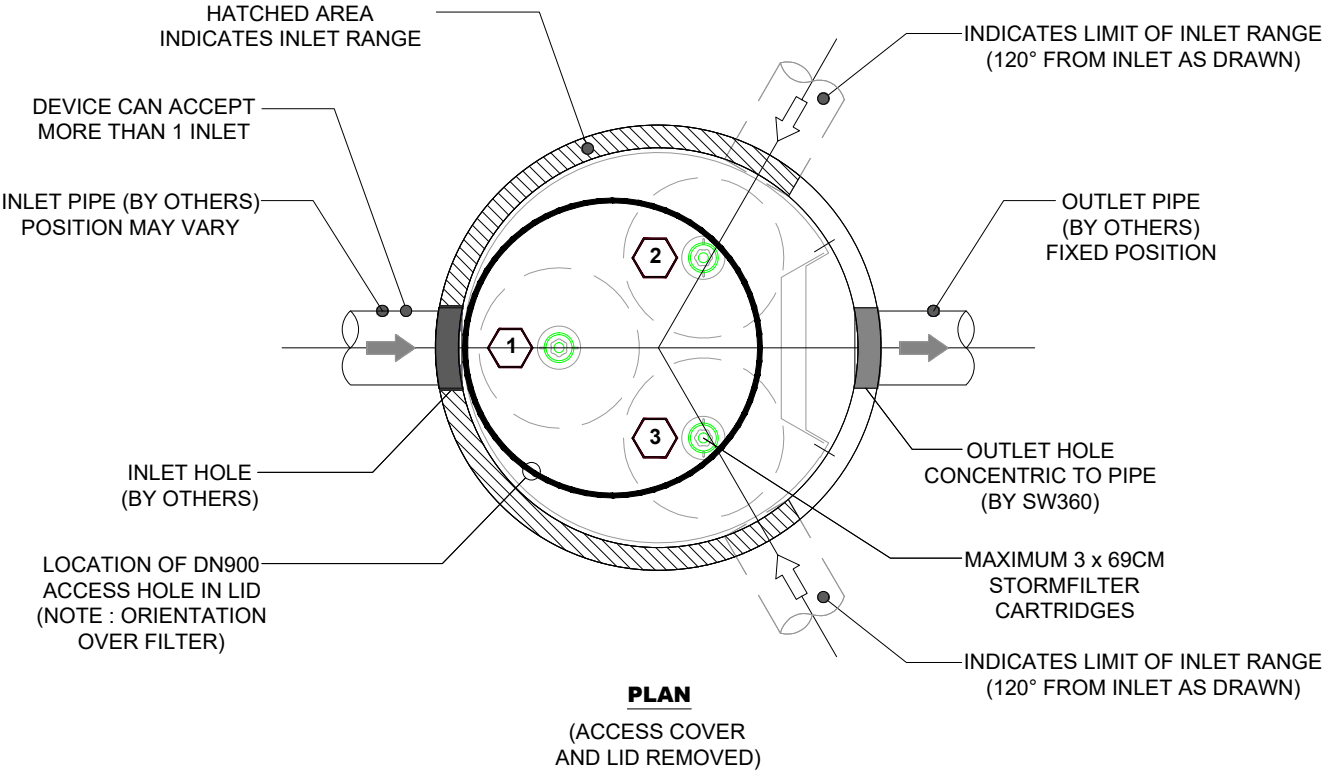

TO BE COMPLETED BY CUSTOMER / CONTRACTOR


COMPANY :	P.O. NUMBER :					
SITE ADDRESS :						
SITE CONTACT & PHONE :						
PREFERRED DELIVERY DATE (TBC SW360) :						
STORMFILTER REFERENCE (IF APPLICABLE) :						
OUTLET HOLE Ø (CIRCLE) : (TYPICAL PIPE MATERIAL)	Ø 130 (DN100 PVC)	Ø 200 (DN150 PVC)	Ø 225 (DN175 PVC)	Ø 275 (DN225 PVC)	Ø 300 (DN225 RRJ)	Ø 350 (DN300 PVC)
LID LEVEL (RL) :	OUTLET PIPE (IL) :			DTI :		
COMPLETED BY :	SIGNED :			DATE :		

TO BE COMPLETED BY SW360

SW360 PRODUCT CODE :				
MEDIA TYPE (CIRCLE ONE) :	PERLITE	ZPG	OTHER :	
CARTRIDGE QTY (STATE) :				PRE-INSTALLATION (Y/N) :
SP FLOW RATE (CIRCLE ONE) :	FULL (Ø 22.7 ID) YELLOW	3 QTR (Ø 19.7 ID) GREEN	HALF (Ø 16.2 ID) BLUE	OTHER :
ACCESS COVER (CIRCLE ONE) :	900 x 900 WEB-FORGE / CLASS D			OTHER :
COMPLETED BY :	SIGNED :			DATE :

SW360 PRODUCTION DATA

OUTLET HOLE DETAILS :  
(CIRCLE REQUIREMENT)

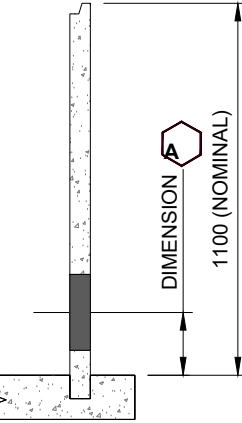

OUTLET HOLE Ø	DIM A
130	120
200	145
225	165
275	190
300	180
350	220

DWG ISSUE No. :

REQUIRED DATE :

NOTES

- MANHOLE UNIT FITTED WITH SWIFTLIFT ANCHOR POINTS (QTY 2). DO NOT EXCEED 60 DEGREE LIFT ANGLE. CONCRETE LID FITTED WITH SWIFTLIFT ANCHOR POINTS (QTY 4).
- UNIT SUPPLIED WITH OUTLET CORE DRILLED. INLET/S CORE DRILLED ON SITE BY OTHERS WITHIN RANGE SHOWN ON DRAWING.
- SEALING / GROUTING OF MANHOLE COMPONENTS AND PIPES BY CONTRACTOR. ENSURING LOCAL CODES AND REGULATIONS ARE COMPLIED WITH.
- ANY RISERS REQUIRED TO INCREASE THE DEPTH TO INVERT (DTI) FROM THAT AS DRAWN TO BE SUPPLIED BY THE CONTRACTOR.
- FOR A DTI EXCEEDING 5m PLEASE CONTACT **0800STORMWATER**.
- CONTRACTOR TO TAKE APPROPRIATE MEASURES TO PROTECT CARTRIDGES FROM CONSTRUCTION RELATED EROSION RUNOFF.
- BACKFILL, BEDDING AND BUOYANCY DESIGN BY ENGINEER OF RECORD
- QTY OF CARTRIDGES BY ENGINEER OF RECORD.
- CONCRETE MANHOLE RISERS ARE DESIGNED AND MANUFACTURED IN ACCORDANCE WITH AS/NZS 4058 : 2007
- CONCRETE MANHOLE BASES ARE DESIGNED AND MANUFACTURED IN ACCORDANCE WITH NZS 3101 : 2006 & NZS 3109 : 1997
- CONCRETE LID DESIGNED AND MANUFACTURED TO HN-HO-72
- FOR REQUIREMENTS OUTSIDE OF DRAWING SPECIFICATIONS PLEASE CONTACT **0800STORMWATER**.

MANHOLE SECTION INCLUDING CARTRIDGES : **1800 Kg**  
(AS DELIVERED, BASED ON QTY 3 ZPG CARTS)  
LID WEIGHT : **550 Kg**

CONCEPT DESIGN  
NOT FOR CONSTRUCTION

No.	Revision	By	Chk	Appd	Date
B	CONCEPT DESIGN	JK	IB	BC	27.03.20
A	FOR APPROVAL	JK	IB	BC	20.03.20

Drawing Originator:

Original Scale (A1)	Design	S.Crundwell	10.03.20	Approved For Construction*
NTS	Drawn	J.Knox	20.03.20	
Reduced Scale (A3)	Dwg Verifier	J.Stanton	20.03.20	Date
NTS	Dwg Check	K.Aulakh	20.03.20	

\* Refer to Revision 1 for Original Signature

Client:



Project:

PARK TERRACE  
RETIREMENT VILLAGE

Title:

PROPOSED DN1050  
STORMWATER 360 TREATMENT  
DEVICE

Discipline

CIVIL ENGINEERING



Drawing No.

038-RCT\_401\_C4-061

Rev.

B



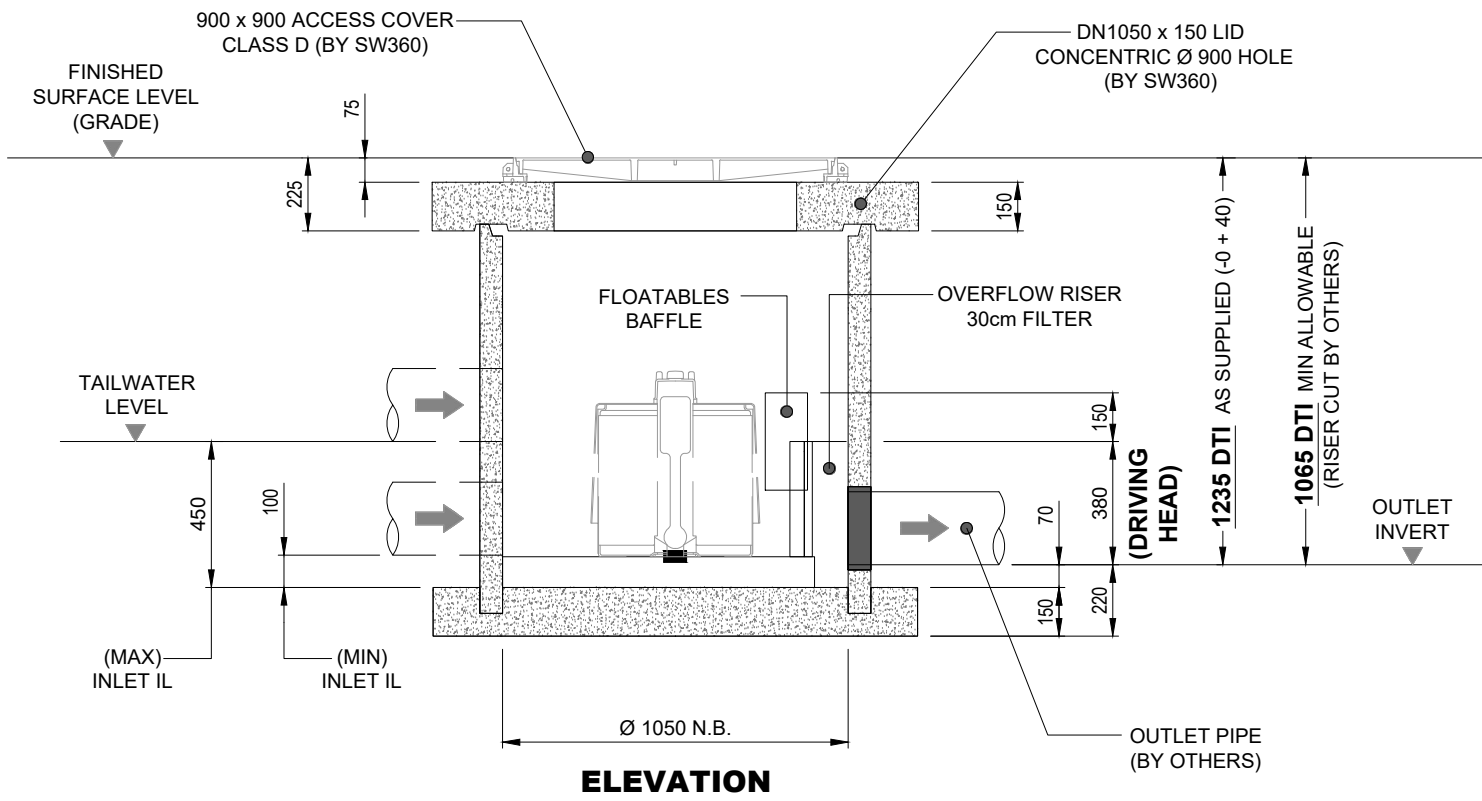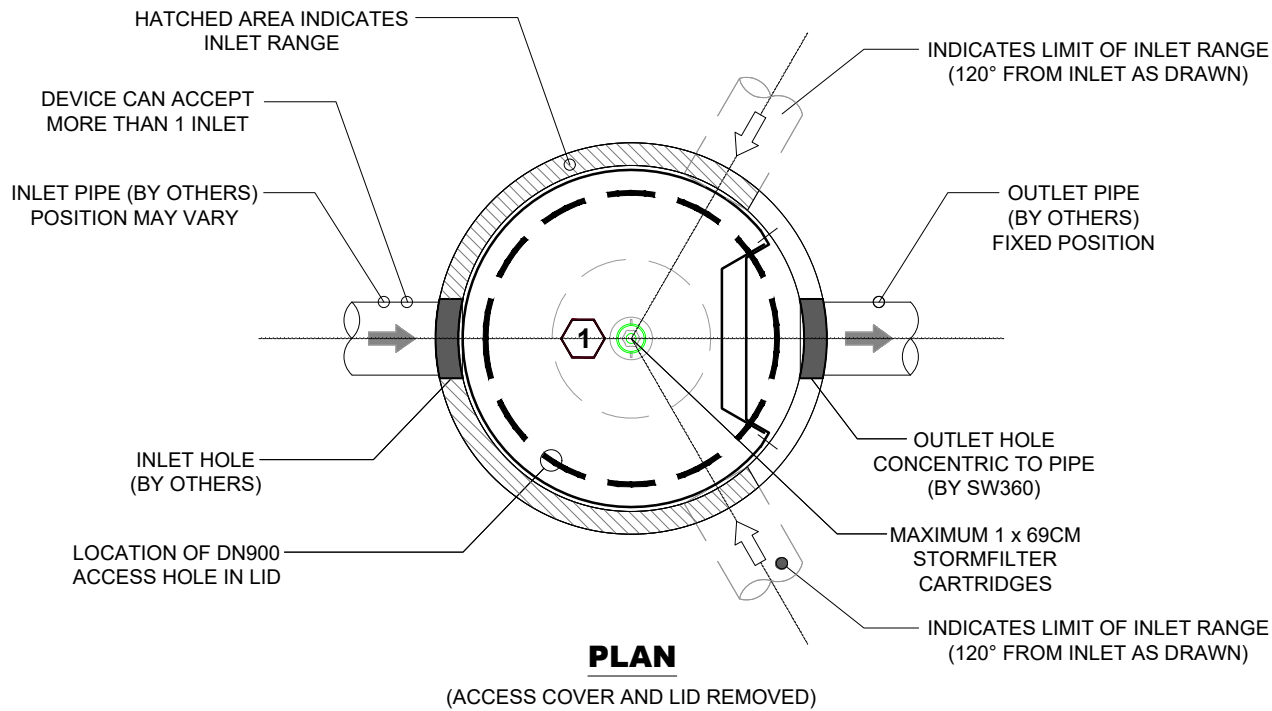

TO BE COMPLETED BY CUSTOMER / CONTRACTOR


COMPANY :		P.O. NUMBER :				
SITE ADDRESS :						
SITE CONTACT & PHONE :						
PREFERRED DELIVERY DATE (TBC SW360) :						
STORMFILTER REFERENCE (IF APPLICABLE) :						
OUTLET HOLE Ø (CIRCLE) : (TYPICAL PIPE MATERIAL)	Ø 130 (DN100 PVC)	Ø 200 (DN150 PVC)	Ø 225 (DN175 PVC)	Ø 275 (DN225 PVC)	Ø 300 (DN225 RRJ)	Ø 350 (DN300 PVC)
LID LEVEL (RL) :	OUTLET PIPE (IL) :				DTI :	
COMPLETED BY :	SIGNED :				DATE :	

TO BE COMPLETED BY SW360

SW360 PRODUCT CODE :					
MEDIA TYPE (CIRCLE ONE) :	PERLITE	ZPG	OTHER :		
CARTRIDGE QTY (STATE) :				PRE-INSTALLATION (Y/N) :	
SP FLOW RATE (CIRCLE ONE) :	FULL (Ø 22.7 ID) YELLOW	3 QTR (Ø 19.7 ID) GREEN	HALF (Ø 16.2 ID) BLUE	OTHER :	
ACCESS COVER (CIRCLE ONE) :	900 x 900 WEB-FORGE / CLASS D			OTHER :	
COMPLETED BY :	SIGNED :			DATE :	

SW360 PRODUCTION DATA

OUTLET HOLE DETAILS :  
(CIRCLE REQUIREMENT)

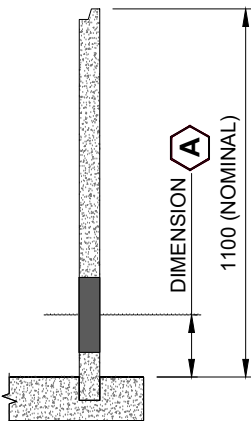

OUTLET HOLE Ø	DIM A
130	120
200	145
225	165
275	190
300	180
350	220

DWG ISSUE No. :

REQUIRED DATE :

NOTES

- MANHOLE UNIT FITTED WITH SWIFTLIFT ANCHOR POINTS (QTY 2). DO NOT EXCEED 60 DEGREE LIFT ANGLE. CONCRETE LID FITTED WITH SWIFTLIFT ANCHOR POINTS (QTY 4).
- UNIT SUPPLIED WITH OUTLET CORE DRILLED. INLET/S CORE DRILLED ON SITE BY OTHERS WITHIN RANGE SHOWN ON DRAWING.
- SEALING / GROUTING OF MANHOLE COMPONENTS AND PIPES BY CONTRACTOR. ENSURING LOCAL CODES AND REGULATIONS ARE COMPLIED WITH.
- ANY RISERS REQUIRED TO INCREASE THE DEPTH TO INVERT (DTI) FROM THAT AS DRAWN TO BE SUPPLIED BY THE CONTRACTOR.
- FOR A DTI EXCEEDING 5m PLEASE CONTACT **0800STORMWATER**.
- CONTRACTOR TO TAKE APPROPRIATE MEASURES TO PROTECT CARTRIDGES FROM CONSTRUCTION RELATED EROSION RUNOFF. BACKFILL, BEDDING AND BUOYANCY DESIGN BY ENGINEER OF RECORD
- QTY OF CARTRIDGES BY ENGINEER OF RECORD.
- CONCRETE MANHOLE RISERS ARE DESIGNED AND MANUFACTURED IN ACCORDANCE WITH AS/NZS 4058 : 2007
- CONCRETE MANHOLE BASES ARE DESIGNED AND MANUFACTURED IN ACCORDANCE WITH NZS 3101 : 2006 & NZS 3109 : 1997
- CONCRETE LID DESIGNED AND MANUFACTURED TO HN-HO-72
- FOR REQUIREMENTS OUTSIDE OF DRAWING SPECIFICATIONS PLEASE CONTACT **0800STORMWATER**.

APPROX WEIGHTS

MANHOLE SECTION INCLUDING CARTRIDGES : **1400 Kg**  
(AS DELIVERED, BASED ON QTY 1 ZPG CARTS)  
LID WEIGHT : **500 Kg**

CONCEPT DESIGN  
NOT FOR CONSTRUCTION

No.	Revision	By	Chk	Appd	Date
B	CONCEPT DESIGN	JK	IB	BC	27.03.20
A	FOR APPROVAL	JK	IB	BC	20.03.20

Drawing Originator:  
**Beca**

Original Scale (A1) NTS	Design S.Crundwell 10.03.20	Approved For Construction*
Reduced Scale (A3) NTS	Drawn J.Knox 20.03.20	
	Design Verifier J.Stanton 20.03.20	
	Dwg Check K.Aulakh 20.03.20	

Client:  
**RYMAN HEALTHCARE**

Project:  
PARK TERRACE  
RETIREMENT VILLAGE

Title:  
PROPOSED DN1200  
STORMWATER 360 TREATMENT  
DEVICE

Discipline:  
CIVIL ENGINEERING  
Drawing No.:  
038-RCT\_401\_C4-062  
Rev.:  
B